# MIXED USE 137 Campbell Hill Rd & 141 Waldron Rd, Chester Hill

Development Application

# **DRAWINGS**

DWG NO.	DRAWING TITLE	SCALE
000	COVER SHEET	
100 C100 101 102 103	COMPOSITE LANDSCAPE PLAN COMPOSITE LANDSCAPE RENDER LANDSCAPE PLAN - GROUND FLOOR LANDSCAPE PLAN - FIRST FLOOR LANDSCAPE PLAN - SEVENTH FLOOR	1:150 1:150 1:150 1:150 1:150
201 202 203	PLANTING PLAN - GROUND FLOOR PLANTING PLAN - FIRST FLOOR PLANTING PLAN - SEVENTH FLOOR	1:150 1:150 1:150
501 502	SPECIFICATION & PLANT SCHEDULE LANDSCAPE DETAILS	As Shown

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B Architectural Coordination
A For DA
Issue Revision Description

 NP
 RS
 07.04.2017

 NP
 RS
 29.03.2017

 Drawn
 Check
 Date

LEGEND





Waldron Hill Projects Pty Ltd c/ 164 Parramatta Rd, Camperdown NSW 2050

137 Campbell Hill Rd & 141 Waldron Rd, Chester Hill NSW 2162 Drawing Name:
COVER PAGE

Sheet\_of
DEVELOPMENT APPLICATION

Scale: Job Number:

Job Number: Drawing Number: Issue: SS17-3516 000 B

WALDRON ROAD

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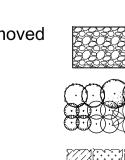
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A For DA

Issue Revision Description

Tree to be Removed Boundary √(Refer Plant Schedule) NP RS 07.04.2017 NP RS 29.03.2017 Drawn Check Date


LEGEND





Groundcover / Grasses

(Refer Plant Schedule)

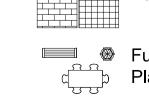



Lawn



Architect:






Waldron Hill Projects Pty Ltd c/ 164 Parramatta Rd, Camperdown NSW 2050

137 Campbell Hill Rd & 141 Waldron Rd, Chester Hill NSW 2162 Composite Landscape Plan

DEVELOPMENT APPLICATION Scale: 1:150 @ A1 Job Number: Drawing Number: SS17-3516

100 B



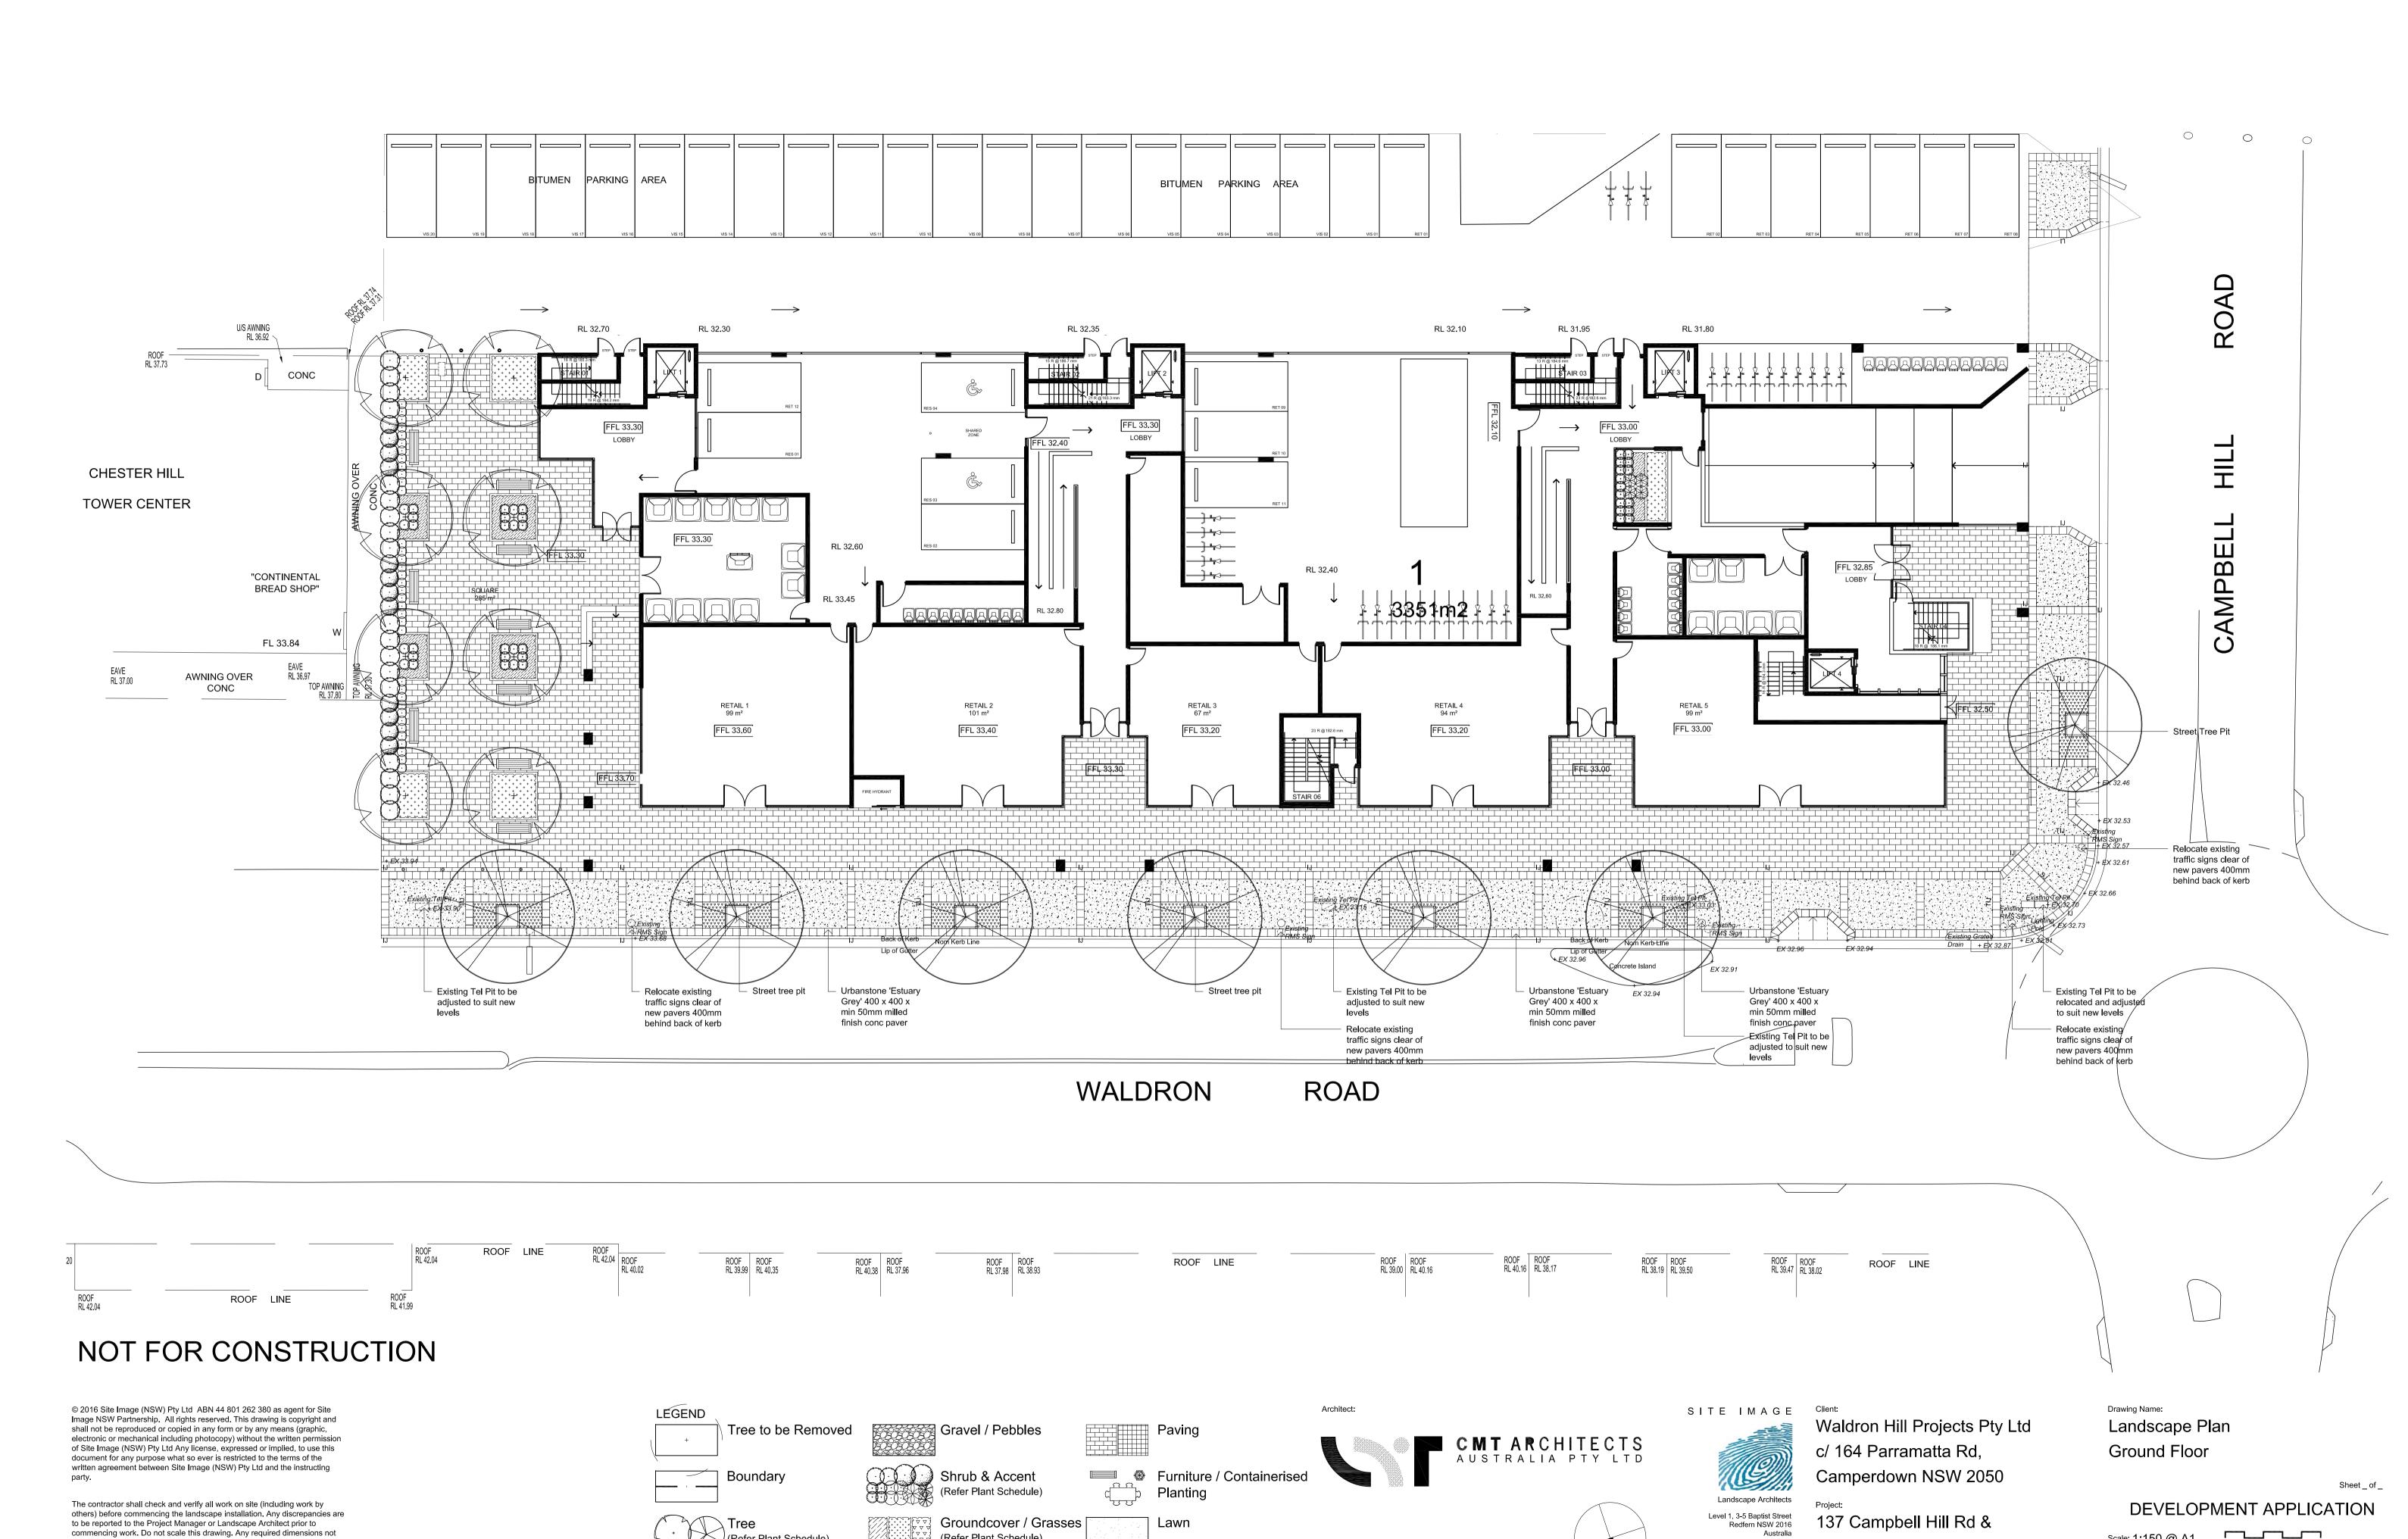

Scale: 1:150 @ A1

SS17-3516

Drawing Number

101 B

Job Number:

141 Waldron Rd,

Chester Hill NSW 2162

Tel: (61 2) 8332 5600

Fax: (61 2) 9698 2877

(Refer Plant Schedule)

NP RS 07.04.2017

NP RS 29.03.2017


Drawn Check Date

B Architectural Coordination

Issue Revision Description

A For DA

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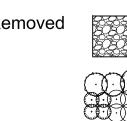
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B Architectural Coordination A For DA Issue Revision Description

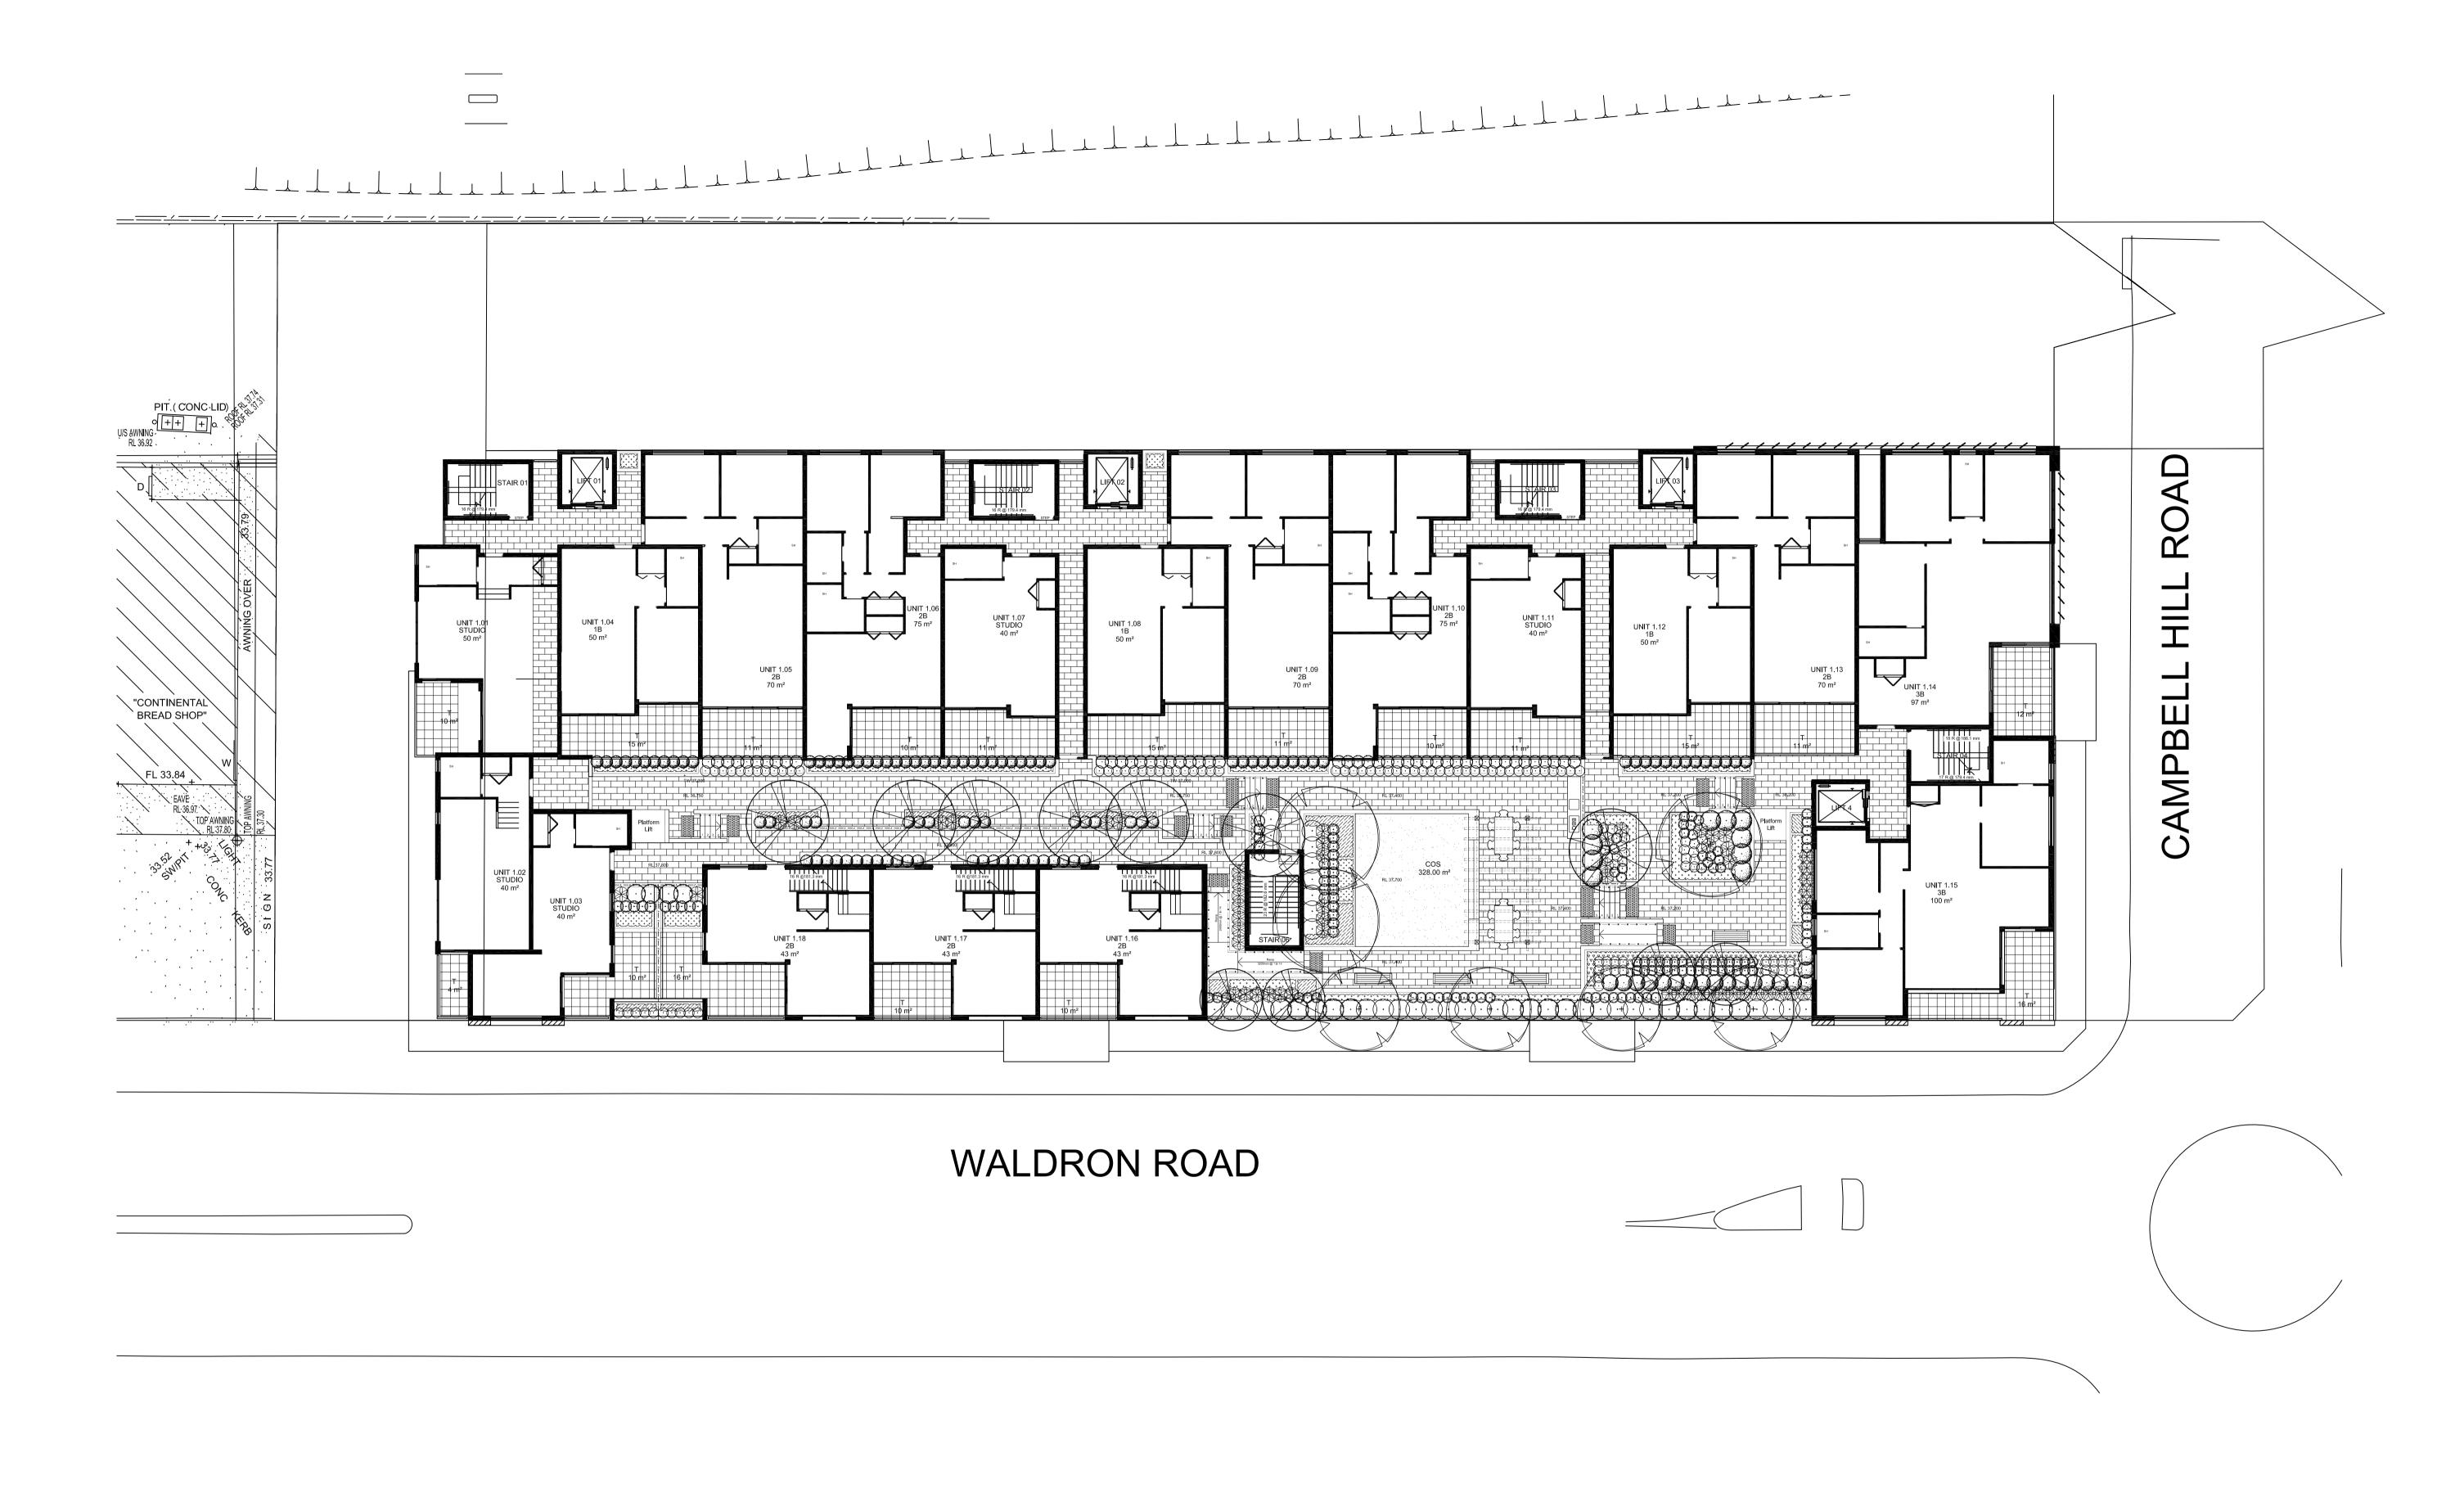NP RS 07.04.2017 NP RS 29.03.2017 Drawn Check Date

Tree to be Removed Boundary


LÉGEND





Groundcover / Grasses

(Refer Plant Schedule)

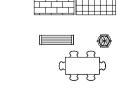






Lawn

Paving

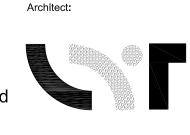






Waldron Hill Projects Pty Ltd c/ 164 Parramatta Rd, Camperdown NSW 2050

137 Campbell Hill Rd & 141 Waldron Rd, Chester Hill NSW 2162

Drawing Name: Landscape Plan First Floor

**DEVELOPMENT APPLICATION** 

Job Number: SS17-3516 102 B

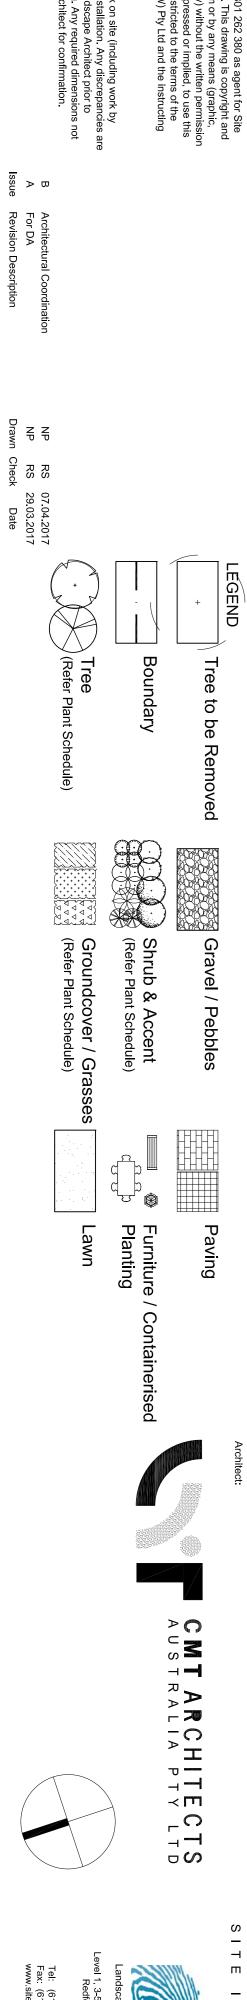


Chester Hill NSW 2162

Waldron Hill Projects Pty Ltd c/ 164 Parramatta Rd, Camperdown NSW 2050 137 Campbell Hill Rd & 141 Waldron Rd,

Landscape Plan
Seventh Floor

Job Number: SS17-3516 le: 1:150 @ A1 DEVELOPMENT APPLICATION 103 B Issue:

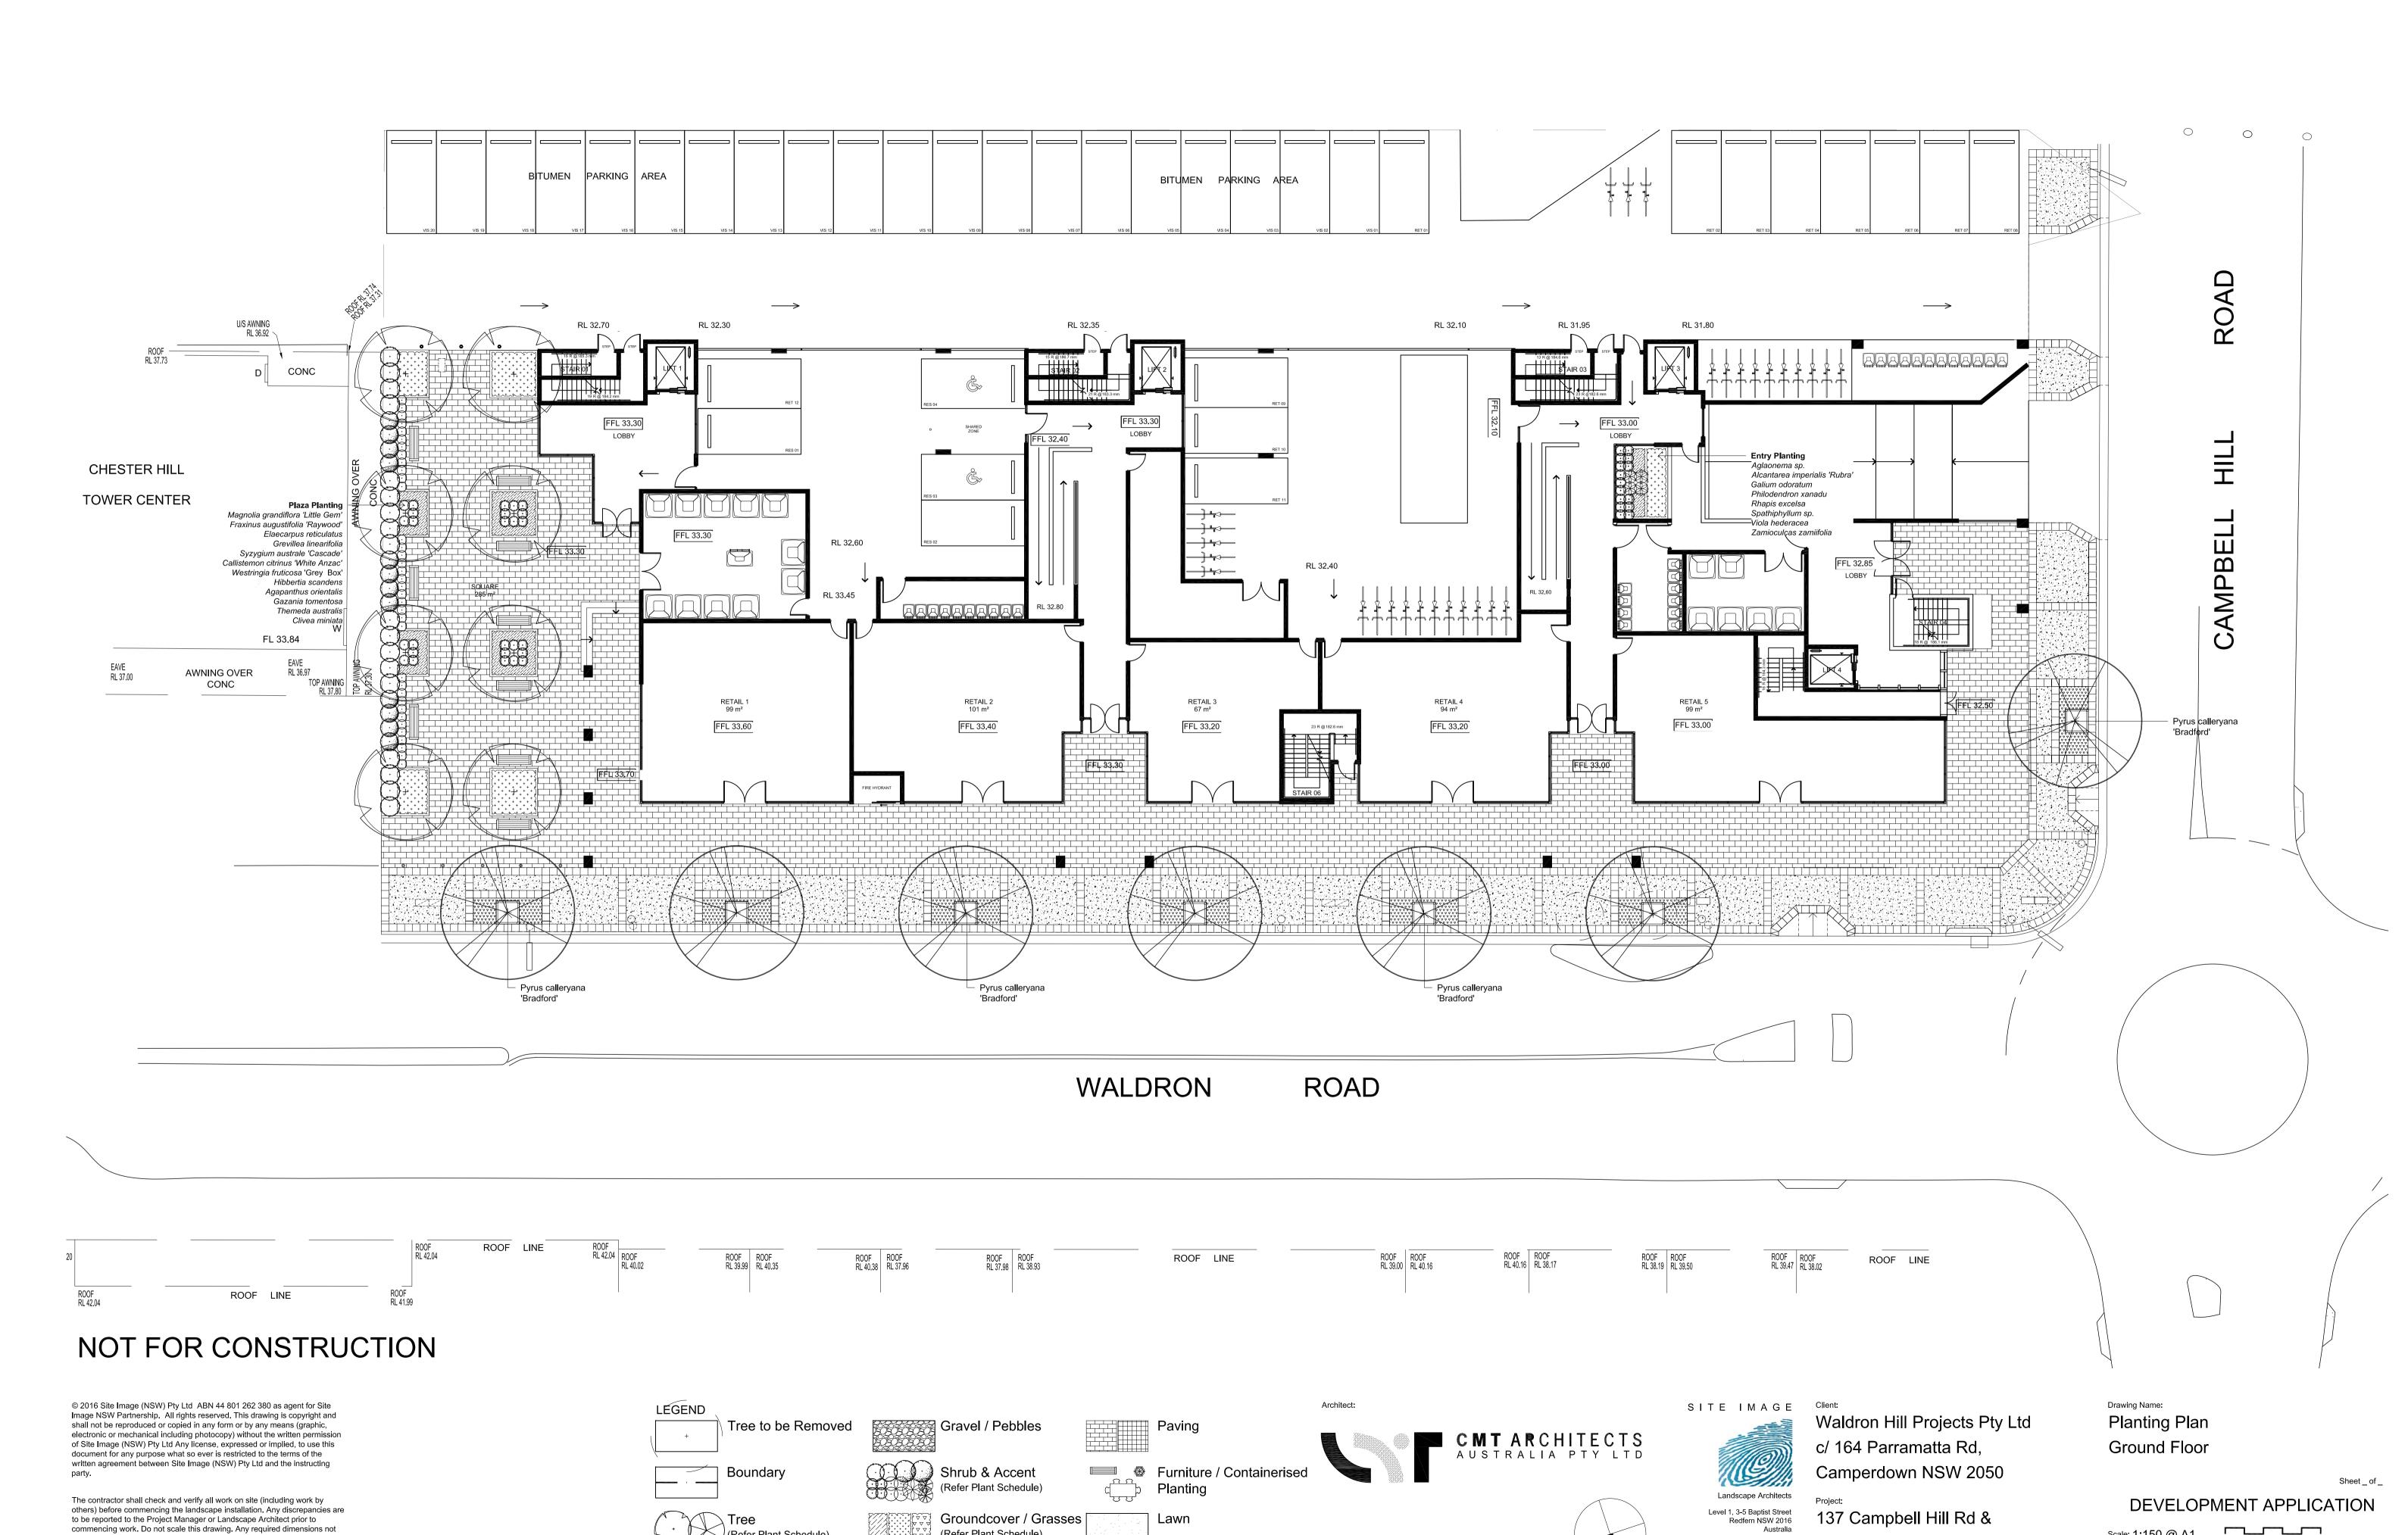

Scale: 1:150 @ A1

SS17-3516

201 B

Job Number:

141 Waldron Rd,

Chester Hill NSW 2162

Tel: (61 2) 8332 5600

Fax: (61 2) 9698 2877

(Refer Plant Schedule)

NP RS 07.04.2017

NP RS 29.03.2017

Drawn Check Date


B Architectural Coordination

Issue Revision Description

A For DA

commencing work. Do not scale this drawing. Any required dimensions not

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B Architectural Coordination A For DA Issue Revision Description

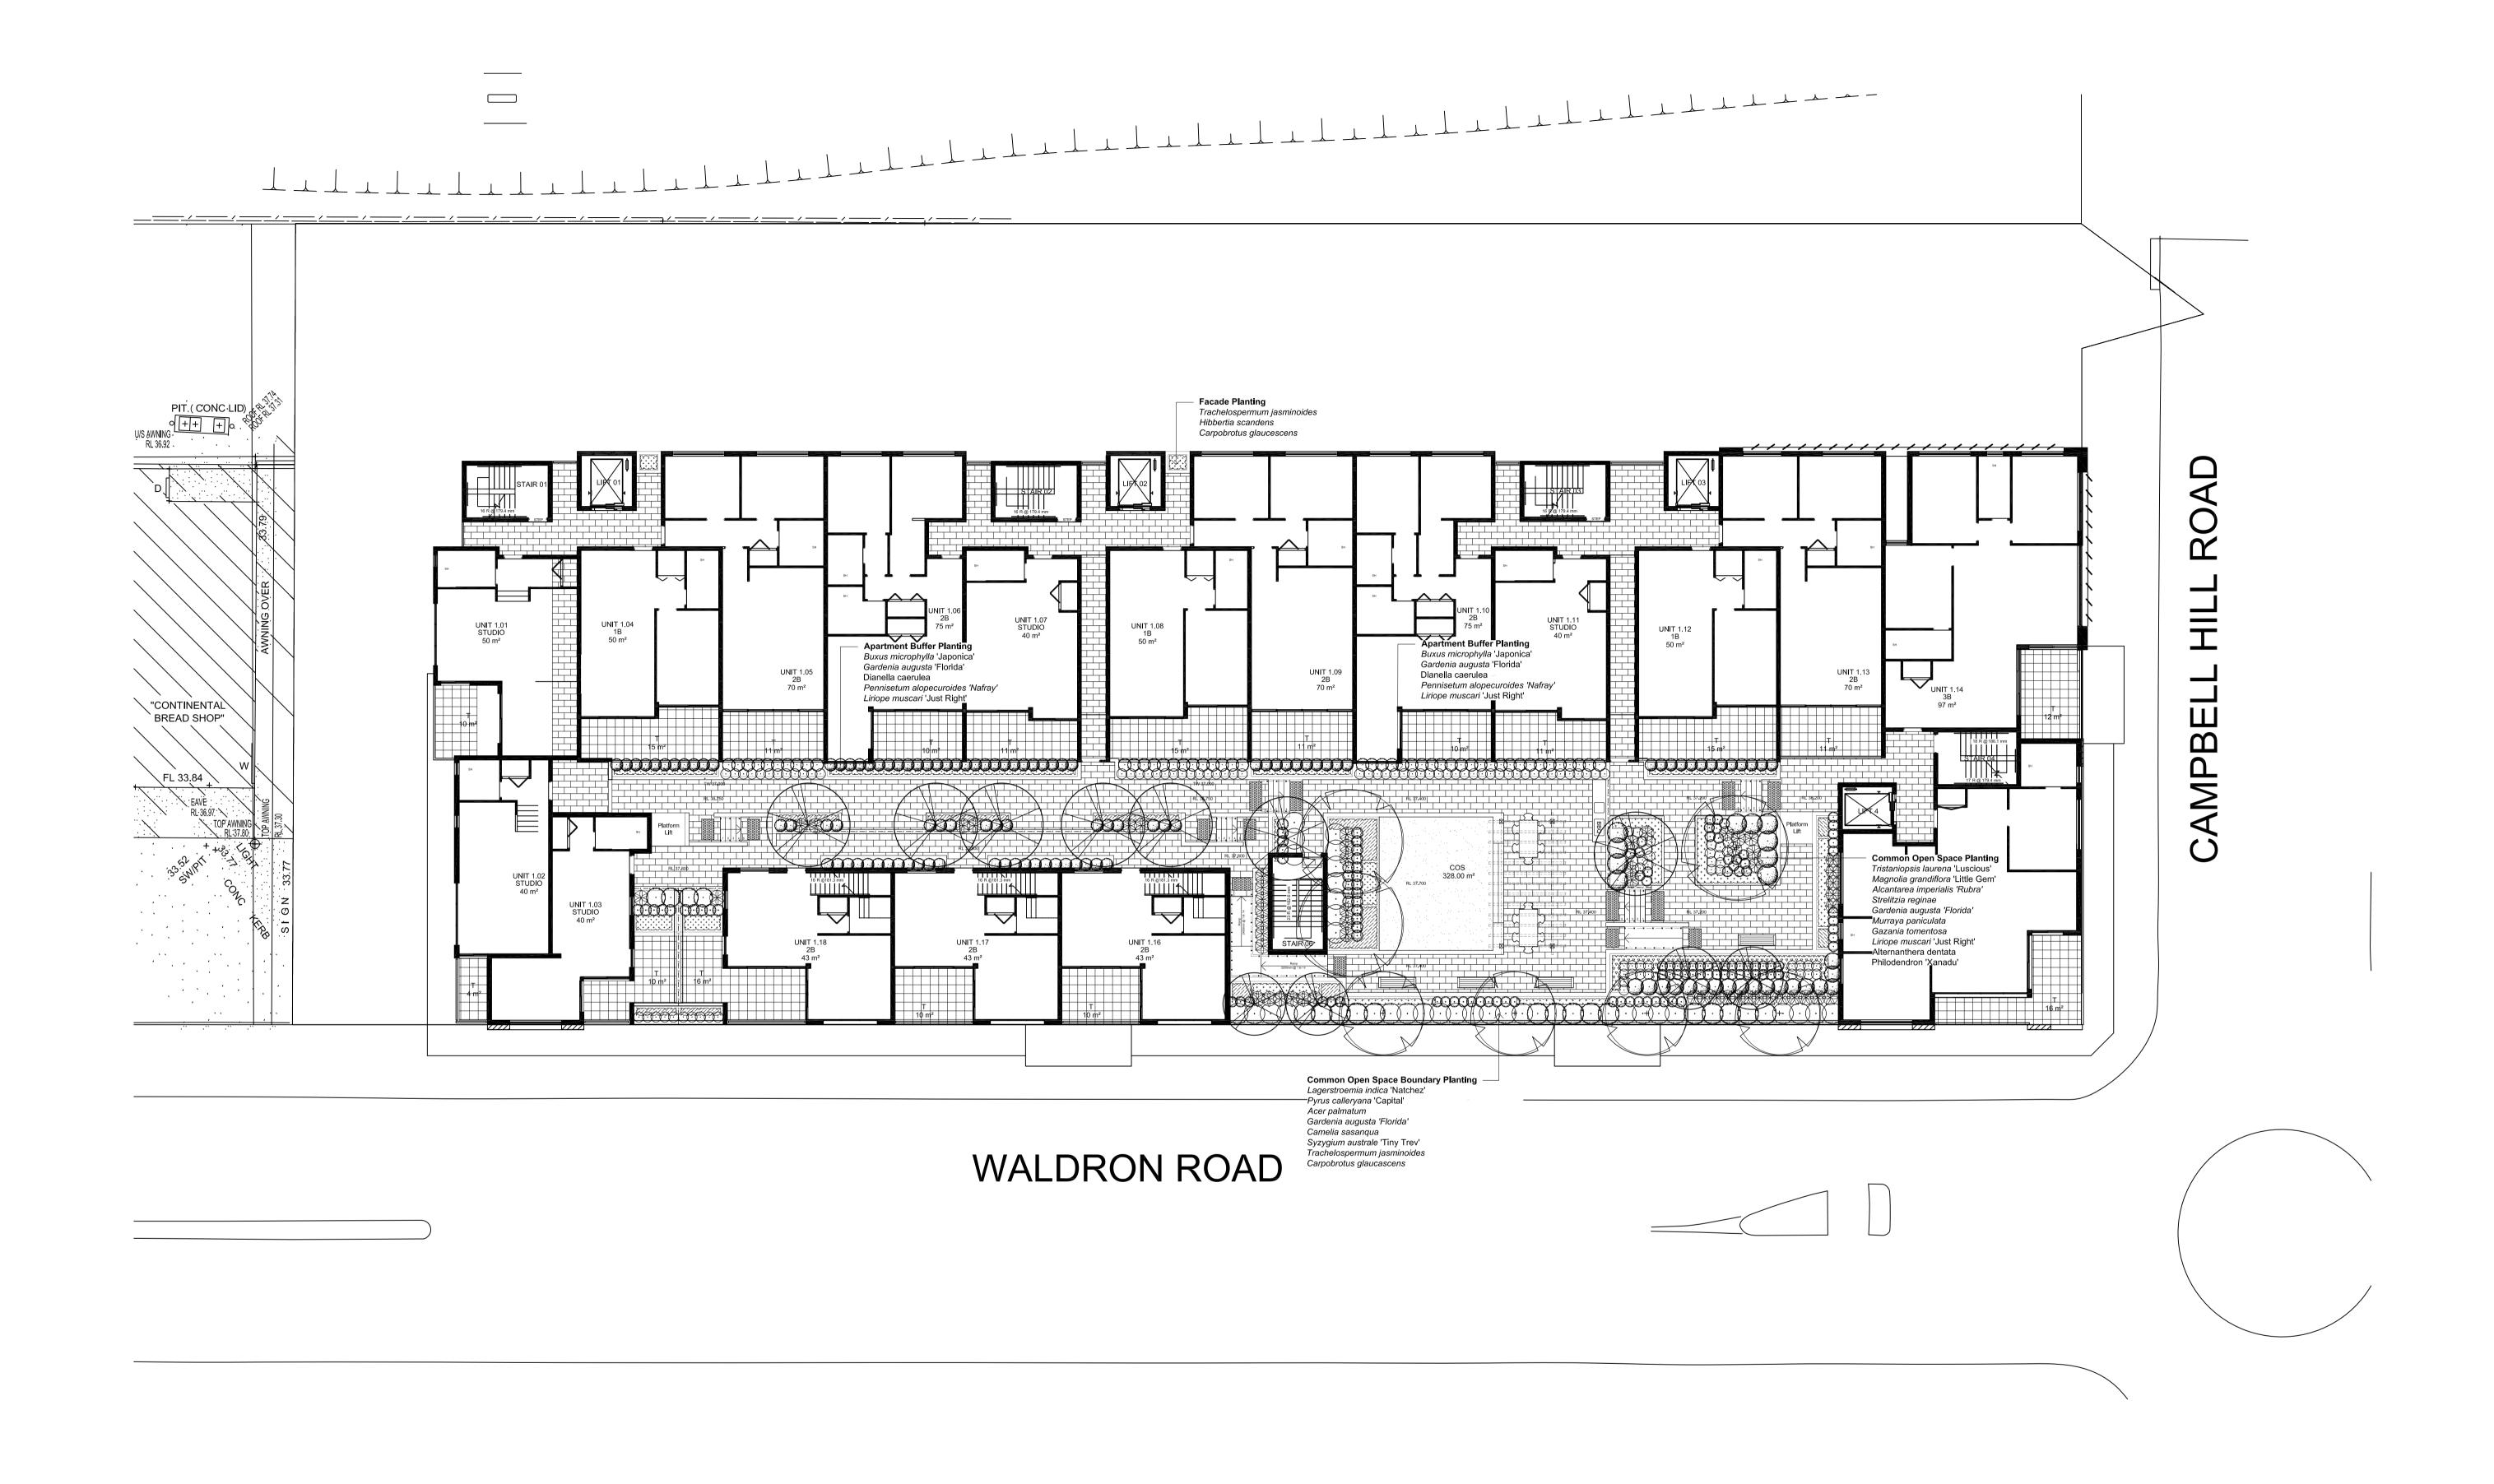NP RS 07.04.2017 NP RS 29.03.2017 Drawn Check Date

Tree to be Removed Boundary

LÉGEND





Gravel / Pebbles

(Refer Plant Schedule)



Groundcover / Grasses

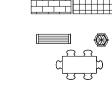

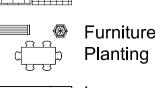

Paving





Architect:






c/ 164 Parramatta Rd, Camperdown NSW 2050

Waldron Hill Projects Pty Ltd

137 Campbell Hill Rd & 141 Waldron Rd, Chester Hill NSW 2162 Drawing Name: Planting Plan First Floor

DEVELOPMENT APPLICATION

Scale: 1:150 @ A1 Job Number: SS17-3516 202 B

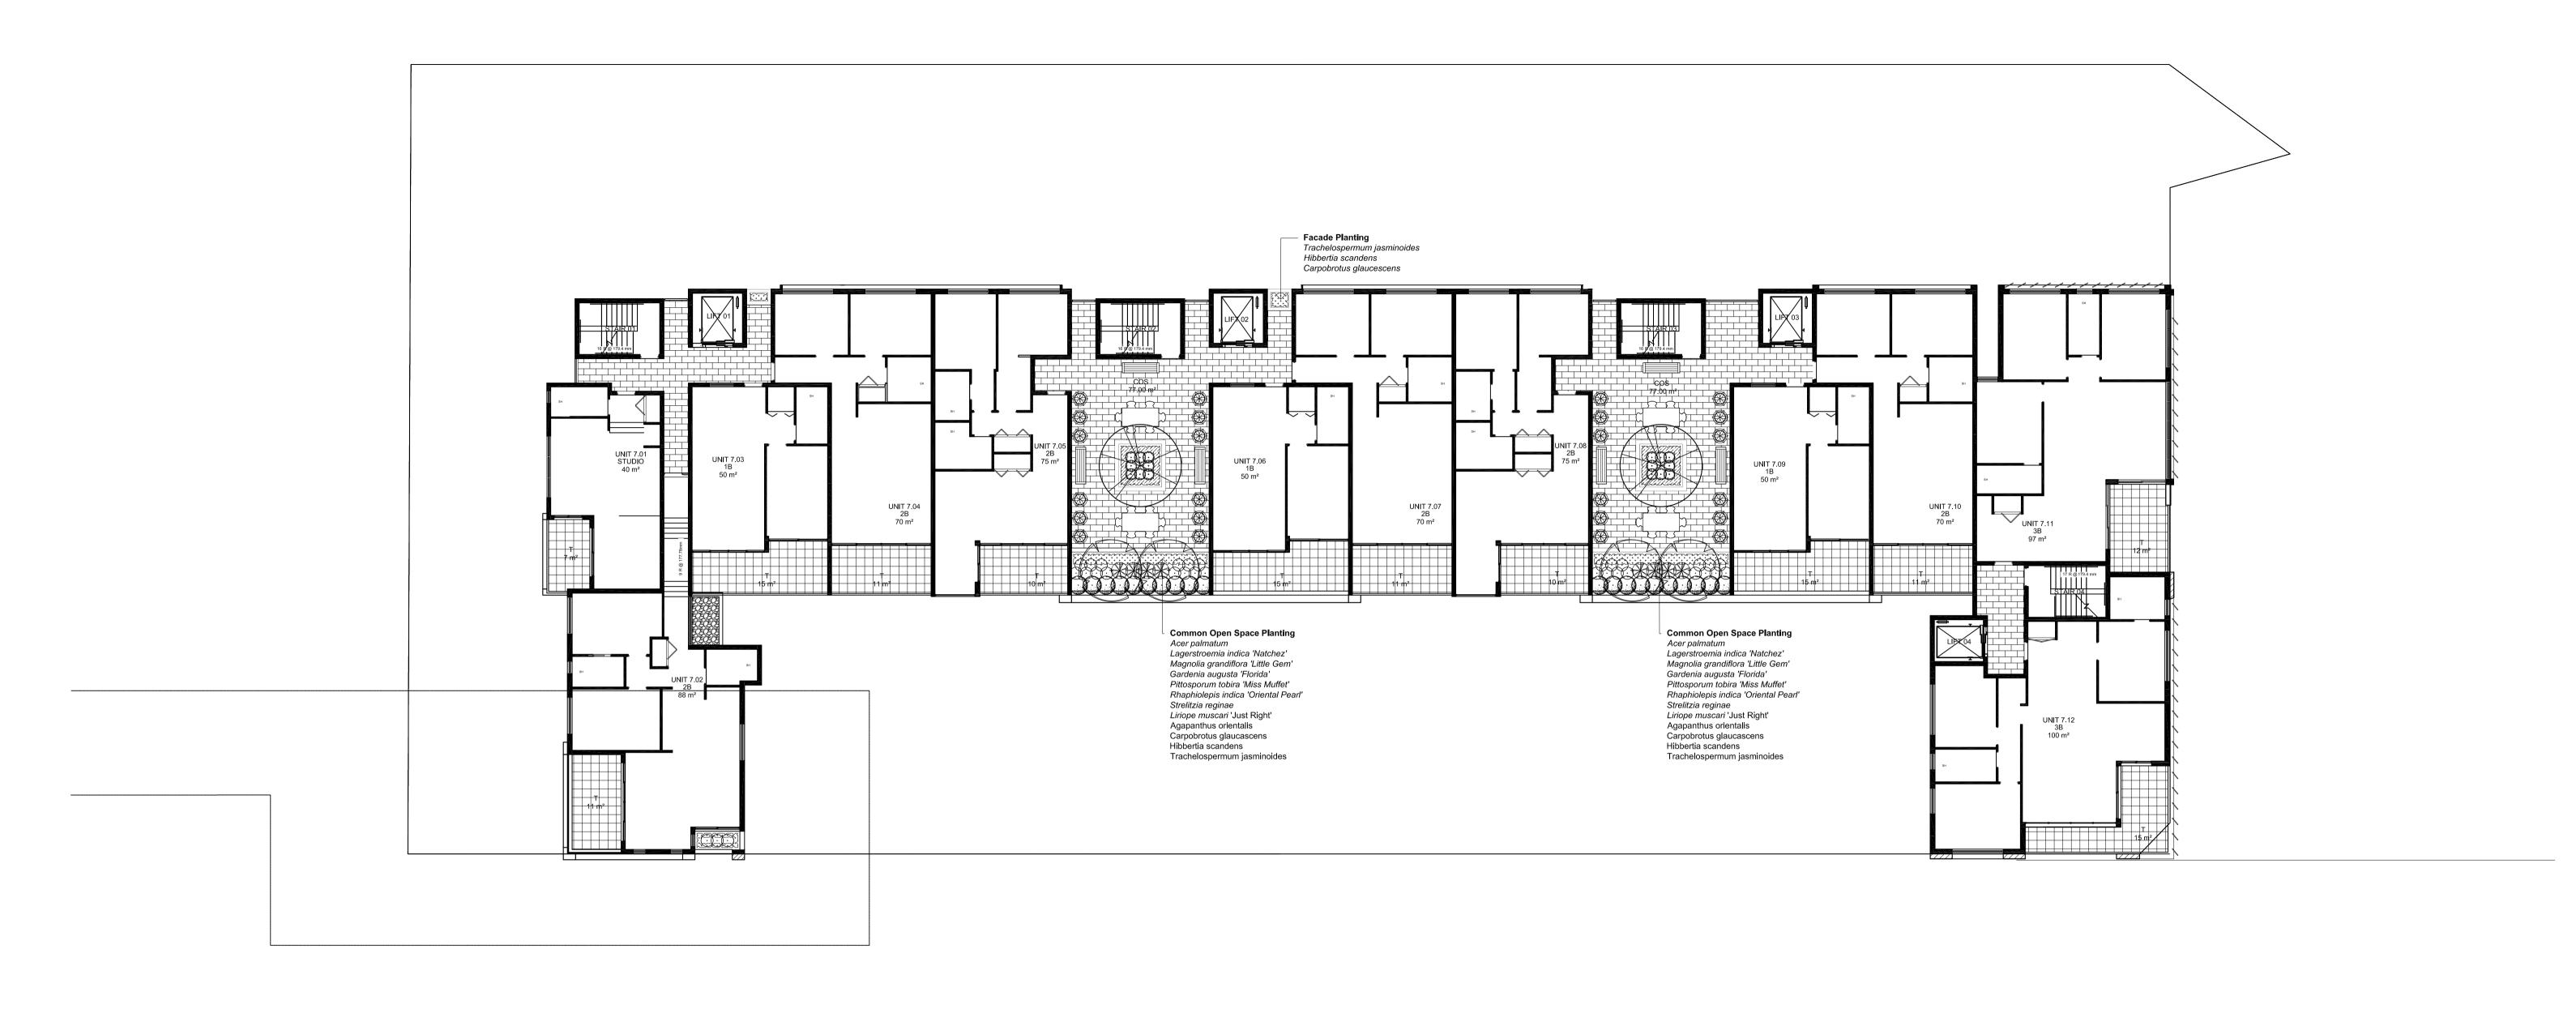


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B Architectural Coordination A For DA Issue Revision Description

NP RS 07.04.2017 NP RS 29.03.2017 Drawn Check Date



LEGEND

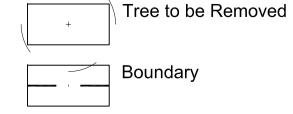





Shrub & Accent

(Refer Plant Schedule)

(Refer Plant Schedule)

Groundcover / Grasses

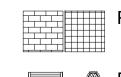

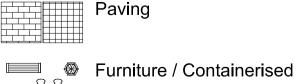



Lawn



Architect:





SITE IMAGE Client: Waldron Hill Projects Pty Ltd c/ 164 Parramatta Rd, Camperdown NSW 2050

137 Campbell Hill Rd & 141 Waldron Rd, Chester Hill NSW 2162 Drawing Name: Planting Plan Seventh Floor

DEVELOPMENT APPLICATION Scale: 1:150 @ A1 Job Number: Drawing Number: SS17-3516 203 B

### **SPECIFICATION GENERAL NOTES**

### References

All plans and details included in the project documents shall be read in conjunction with this specification. All structural and civil works components of the landscape design shall be to engineers' details and referenced specifications. Read this specification conjunction with the plant and materials schedules on the drawings. If in doubt about any detail or if conflicts are found in the documents, seek advice.

### **Workmanship and Materials**

The whole of the landscape works shall be carried out by a competent, trained and qualified landscape contractor who is experienced in horticultural practices, landscape construction and planting techniques. The landscape contractor shall hold a current Building Contractors License and/or be a financial member of LNA Landscape Association NSW & ACT or equivalent organisations in other states.

### **HARDWORKS**

# Furniture, Handrails, Balustrades

Supply and install the scheduled items in manufacturer's recommendations, as detailed and in the locations shown on plan. Provide all footings and fixings required for the items to be stable and in accordance with applicable codes and standards.

### Garden Walls, Fences, Steps, TGSI and Edging

Construct garden walls, fences, steps, TGSI and edging as shown on plan, as detailed and of the material scheduled. Provide footings, step nosings, tactile surfaces to comply with standards and applicable legislation. Refer to engineer's details for structural retaining walls. heavy duty slabs, concrete stairs, concrete strength, reinforcing and joint placement.

# Continuous. Unit and Loose Pavement

locations shown on plan. Ensure that all subgrade/subsurface works are complete prior to commencing paving. Confer with the engineer to ensure the structural integrity of the subgrade. Ensure that the base course under paved surfaces is a continuous plane offering a constant depth of bedding material not exceeding 50mm.

# **SOFTWORKS**

# Topsoil

Import topsoil for the garden and turf areas, unless the topsoil can be provided from material recovered from the site, as recommended in the soil testing results. Spread the topsoil on the prepared subsoil and grade evenly, compact lightly and uniformly in 150mm layers. Avoid differential subsidence and excess compaction and produce a finished topsoil surface which has the following characteristics:

- Finished to design levels, allowing for mulch or turf, which is to finish flush with adjoining
- hard surfaces such as paths and edges; Smooth and free from inorganic matter, stones
- Graded to drain freely, without ponding, to catchment and/or sub-soil drains;
- Graded evenly to adjoining surfaces; and

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to be reported to the Project Manager or Landscape Architect prior to

others) before commencing the landscape installation. Any discrepancies are

commencing work. Do not scale this drawing. Any required dimensions not shown shall be referred to the Landscape Architect for confirmation.

Ready for planting

or clods of soil;

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# Compost

Provide, in accordance with AS 4454, well rotted vegetative material or animal manure, free from harmful chemicals, inorganic matter, grass, weeds and the reproductive parts of unwanted

Provide proprietary fertilisers, delivered to the site in sealed containers marked to show manufacturer or vendor, weight, fertiliser type, N:P:K ratio, recommended uses, application rates and safety procedures. Apply appropriate fertiliser suited to the provenance of plants (indigenous or exotic) included in the design.

Supply plants in accordance with the landscape design drawings and schedules, which have the following characteristics:

- Large healthy root systems, with no evidence of root curl, restriction or damage;
- Vigorous, well established, free from disease and pests, of good form consistent with the species/variety;
- Hardened off, not soft or forced, and suitable for planting in the natural climatic conditions prevailing at the site in full sun, partial shade or full shade conditions:
- Grown in final containers for not less than twelve weeks:
- Trees, unless required to be multi-stemmed, shall have a single leading shoot; and
- Containers shall be free from weeds and of appropriate size in relation to the specified plant size.

### Plant Installation

Following excavation of the planting hole, place and spread 15gms of wetting agent pre-mixed with one (1) litre of water. Place the plant correctly orientated to north or for best presentation. Backfill the planting holes with specified topsoil mixture. Lightly tamp and water to eliminate air pockets. Ensure that the backfill soil is not placed over the top of the root ball and that the root ball is not higher than the soil in which it is planted. Apply fertiliser, as specified around the plants in the soil at the time of

# Root Barrier

Supply and install root control barriers to all new tree plantings adjacent to walls, paths, kerbs and all service trenches, where their proximity poses a threat to the stability of the built infrastructure. Install in accordance with manufacturer's recommendations.

# Mulch

Unless noted otherwise, mulch shall be approved proprietary recycled wood fibre or pine bark material. Place mulch in all garden beds to a depth of 75mm after all specified plants are installed. Keep mulch clear of all plant stems and rake to an even plane, flush with the surrounding surfaces evenly graded between design surface levels. Over fill to allow mulch to settle to the specified depth.

# Stakes and Ties

Stakes shall be durable hardwood, straight, free of knots and twists, pointed at one end, in the following quantities and sizes for each of the various plant pot sizes:

- Plants (>25 lt): 1 off 38 x 38 x 1200mm;
- Semi-advanced plants (>75 lt): 2 off 50x50x
- Advanced (>100 lt): 3 off 50 x 50 x 2400mm.

# **LEGEND**

### **IRRIGATION**

All proposed landscape areas shall be irrigated.

The irrigation system shall be an automatic permanent system, with an irrigation controller self operated via a soil moisture sensor. The system shall be calibrated to deliver the optimum rate and volume of water appropriate to the type of plants in the design. The system shall be adjustable and fully serviceable. The layout of the entire irrigation system shall focus on delivering the required amount of water to maintain healthy and vigorous growth. The irrigation system shall be such that, component theft, vandalism, over-spray and wetting of paths shall be reduced to a minimum or completely eliminated by the use of drip, pop-up sprinklers and judiciously placed fixed spray emitters. Generally do not use fine mist emitters that provide a drifting mist that may wet paths and the buildings unless specifically required by the design.

### LANDSCAPE MAINTENANCE

The Landscape Contractor shall rectify defects during installation and that become apparent in the works under normal use for the duration of the contract Defects Liability Period. Unless contracted otherwise, the Landscape Contractor shall maintain the contract areas by the implementation of industry accepted horticultural practices for 52 weeks from Practical Completion of the works. The landscape maintenance works shall include, but not be limited to:

- Replacing failed plants;
- Pruning;
- Insect and pest control:
- Fertilising;
- Maintaining and removing stakes and ties;
- Maintaining mulch; Mowing and top dressing;
- Irrigation and watering;
- Erosion control; and
- Weeding and rubbish removal.

Maintenance Log Book

Implement and keep a maintenance log book recording when and what maintenance work has been undertaken and what materials, actions and decisions have been used, implemented and concluded to keep the landscape always looking its best. Enter data daily and review information every 2 weeks. Observe trends and develop a maintenance regime around seasonal and observed event occurrences.

# **Maintenance Activities**

During the defects maintenance period schedule the following activities to occur on a timely basis.

- Plant replacement Replace plants that have failed to mature, die or are damaged. Replacement plants shall be in a similar size and quality and identical species or variety to the plant that has failed. Replacement of plants shall be at the cost of the landscape contractor unless advised otherwise. If the cause of the failure is due to a controllable situation then correct the situation prior to replacing plants. Observe and replace failed plants within 2 weeks of observation.
- Pruning Prune dead wood, broken limbs, dead or infected foliage and as needed to develop strong, healthy plants to achieve the shape and form expected of the plant type. Observe daily and prune plants on a needs
- Insect, disease and pest control Avoid spraying
- if ever possible;
- in wet weather or if wet weather is

## imminent:

- if target plants are still wet after rain; 0
- o in windy weather; and

if non-target species are too close. Immediately report to the Project Manager any evidence of intensive weed infestation. insect attack or disease amongst plant material. Submit all proposals to apply chemicals and obtain approval before starting this work. When approved, spray with insecticide, fungicide herbicide, appropriate in accordance manufacturers' recommendations. Observe daily and act as necessary to control any infestation or disease. Record in the logbook all relevant details of spraying activities including:

- Product brand / manufacturer's name,
- Chemical / product name,
- Chemical contents,
- Application quantity and rate, Date of application and location,
- Results of application, and
- Use approval authority. Fertilising - Fertilise gardens with a
- proprietary slow release fertiliser applied in accordance with the manufacturer's directions and recommendations. Apply 6-12 monthly. Record in the logbook all relevant details of
- fertilising including: Product brand / manufacturer's name,
- Fertiliser / product name, Application quantity and rate, and
- Date of application and location.
- Stakes and ties Adjust and replace as required to ensure plants remain correctly staked. Remove those not required at the end of the planting establishment period (Defects Liability Period). Inspect and act at least every 2 weeks
- Maintaining mulch Maintain the surface in a clean, tidy and weed free condition and reinstate the mulch as necessary to ensure correct depth as specified. Observe weekly and replenish mulch as required.
- Mowing and top dressing Mow the turf to maintain a grass height of between 30-50mm. Do not remove more than one third of the grass height at any one time. Remove grass clippings from the site after each mowing. Top dress to a maximum of 10mm to fill depressions and hollows in the surface. Mow weekly/fortnightly in warmer months. Mow monthly or as required in cooler months. Top dress at approximately 6 monthly intervals.
- Irrigation and watering Maintain the irrigation system to sure that each individual plant receives the required amount of water to maintain healthy and vigorous growth. Adjust and calibrate as required. Provide additional watering, if necessary but inspect irrigation
- weekly and make repairs as necessary. **Erosion control** - Where necessary, maintain the erosion control fabric in a tidy and weed free condition and reinstate as necessary to ensure control measures are effective where deemed necessary. Inspect every 2 weeks and act to repair any damage as soon as
- Weeding and rubbish removal During the plant establishment period remove by hand, rubbish and weed growth that may occur or re-occur throughout all planted, mulched and paved areas. The contractor shall target weeds that are capable of producing a major infestation of unwanted plants by seed distribution. Whenever possible, time weed removal to precede flowering and seed set. Constant observation and removal of weeds is essential.

Symbol	Botanical Name	Common Name	Mature size	Pot size
			H x W (m)	
Trees	•	•		
Ap	Acer palmatum	Japanese Maple	4 x 4	100L
Bs	Banksia serrata	Old Man Banksia	5 x 3	45L
Ca	Cupaniopsis anacardioides	Tuckeroo	12 x 5	100L
Er	Eleocarpus reticulatus	Blueberry Ash	12 x 5	100L
FR	Fraxinus augustifolia 'Raywood'	Claret Ash	15 x 7	100L
LiN	Lagerstroemia indica 'Natchez'	Crepe Myrtle	6 x 3	100L
MLG	Magnolia grandiflora 'Little Gem'	Little Gem Magnolia	5 x 3	45L
PB	Pyrus calleryana 'Bradford'	Bradford	10 x 5	100L
PC	Pyrus calleryana 'Captial'	Callery Pear	12 x 3	45L
TL	Tristaniopsis laurina 'Luscious'	Watergum	10 x 6	100L
<b>! !</b>	Triotariiopoio iaanna Laccicae	Vatergani	10 / 0	TOOL
Shrub & A	Accent Planting			
Ae	Aspidistra elatior	Cast Iron Plant	0.7 x 0.5	300mm
AiR	Alcantarea imperialis 'Rubra'	Giant Bromeliad	2.5 x 1.5	300mm
Asm	Acmena smithii 'Minor'	Lilypilly	2 x 1.5	300mm
Bp	Banksia spinosa	Hairpin Banksia	1.5 x 1.0	300mm
BmJ	Buxus microphylla 'Japonica'	Japanese box hedge	2.5 x 2	300mm
CW	Callistemon citrinus 'White Anzac'	Lemon Scented Bottlebrush	3 x 2	300mm
Cl	Callistemon linearis	Narrow-leaved Bottlebrush		300mm
			1.5 x 2	
Cs De	Camelia sasanqua Doryanthes excelsor	Camelia Gymea lilly	4 x 3	300mm
GaF	Gardenia augusta 'Florida'	Gardenia	3 x 2 0.5 x 1.5	300mm 300mm
	Grevillea linearifolia			
GI		White Spider Flower	2 x 1	300mm
GRG	Grevillea 'Robyn Gordon'	Grevillea	1.5 x 2	300mm
Mp	Murraya paniculata	Orange Jessamine	3 x 2	300mm
PBB	Phormium 'Bronze Baby'	Bronze NZ Flax	0.7 x 0.8	300mm
PGP	Pittosporum 'Green Pillar'	Green Pillar	3 x 3	300mm
PMM	Pittosporum tobira 'Miss Muffet'	Dwarf Pittosporum	1 x 1.5	300mm
PX	Philodendron 'Xanadu'	Dwarf Philodendron	1 x 1	300mm
Re	Raphis excelsa	Lady Palm	2 x 1	300mm
ROP	Rhaphiolepis indica 'Oriental Pearl'	Oriental Pearl Indian Hawthorne	1 x 1	300mm
SC	Syzygium australe 'Cascade'	Weeping Lilly Pilly	3 x 1.5	300mm
SaTT	Syzygium australe 'Tiny Trev'	Dwarf Lilly Pilly	0.7 x 0.5	300mm
Sr	Strelitzia reginae	Bird Of Paradise	1.2 x 1.5	300mm
WGB	Westringia fruiticosa 'Grey Box'	Dwarf Coastal Rosemary	0.5 x 0.5	300mm
	& Groundcovers	1	4 05	450
Ao	Agapanthus orientalis	Agapanthus	1 x 0.5	150mm
Ad	Alternanthera dentata	Ruby Leaf Alternanthera	0.45 x	150mm
Cg	Carpobrotus glaucascens	Pig Face	0.2 x 1	150mm
Cm	Clivea miniata	Kaffir Lily	0.45 x 0.4	150mm
DC	Dianella caerulea	Blue Flax Lily	0.8 x 0.8	150mm
DSS	Dianella 'Silver Streak'	Silver Streak Flax Lily	0.5 x 0.4	150mm
Gt	Gazania tomentosa	Gazania	0.15 x 1.5	150mm
Hs	Hibbertia scandens	Native Guniea Flower	0.4 x 1	150mm
PN	Pennisetum alopecuroides 'Nafray'	Nafray Swamp Foxtail	0.6 x 0.6	150mm
LJR	Liriope muscari 'Just Right'	Turf Lily	0.5 x 0.5	150mm
Мр	Myoporum parvifolium	Creeping Boobialla	0.2 x 1.5	150mm
Та	Themeda australis	Kangaroo grass	0.3 x 0.5	150mm
Tj	Trachelospermum jasminoides	Star Jasmine	0.3 x 0.5	150mm
Vh	Viola hederacea	Native Voilet	0.2 x 0.4	150mm

137 Campbell Hill Rd & 141 Waldron Rd, Chester Hill - PLANT SCHEDULE



Fax: (61 2) 9698 287

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Waldron Hill Projects Pty Ltd c/ 164 Parramatta Rd. Camperdown NSW 2050

Landscape Specification & Plant Schdule

**DEVELOPMENT APPLICATION** 

Job Number: SS17-3516

Architectural Coordination A For DA Issue Revision Description


NP RS 29.03.2017 Drawn Check Date

137 Campbell Hill Rd & 141 Waldron Rd, Chester Hill NSW 2162


**Drawing Number** 

501 B


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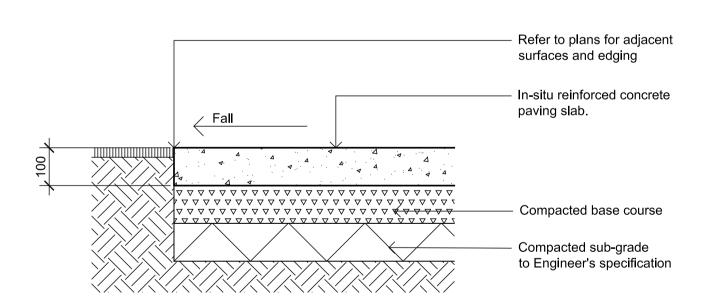
PRECAST UNIT PAVERS ON CONC SLAB SCALE 1:10

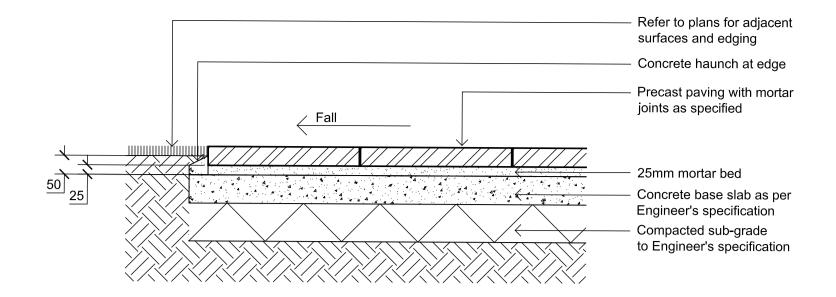


PRECAST UNIT PAVERS ON SUSPENDED SLAB SCALE 1:10

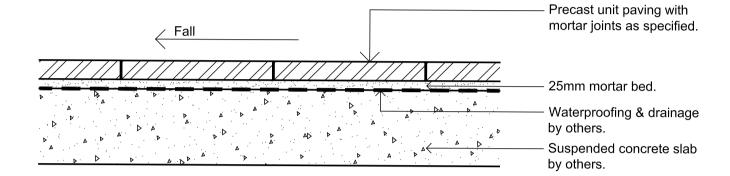



<u>DETAIL - TURF ON SUSPENDED SLAB</u>

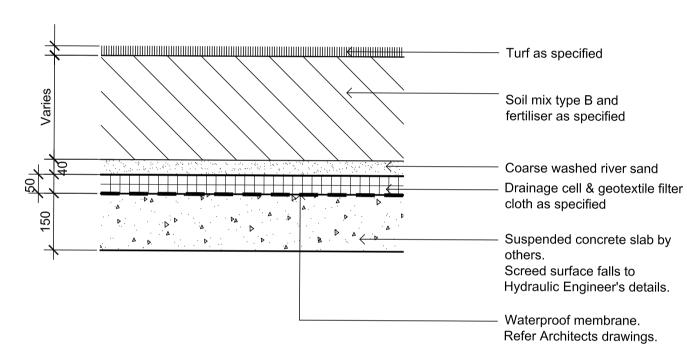

INSITU CONCRETE PAVING SCALE 1:10

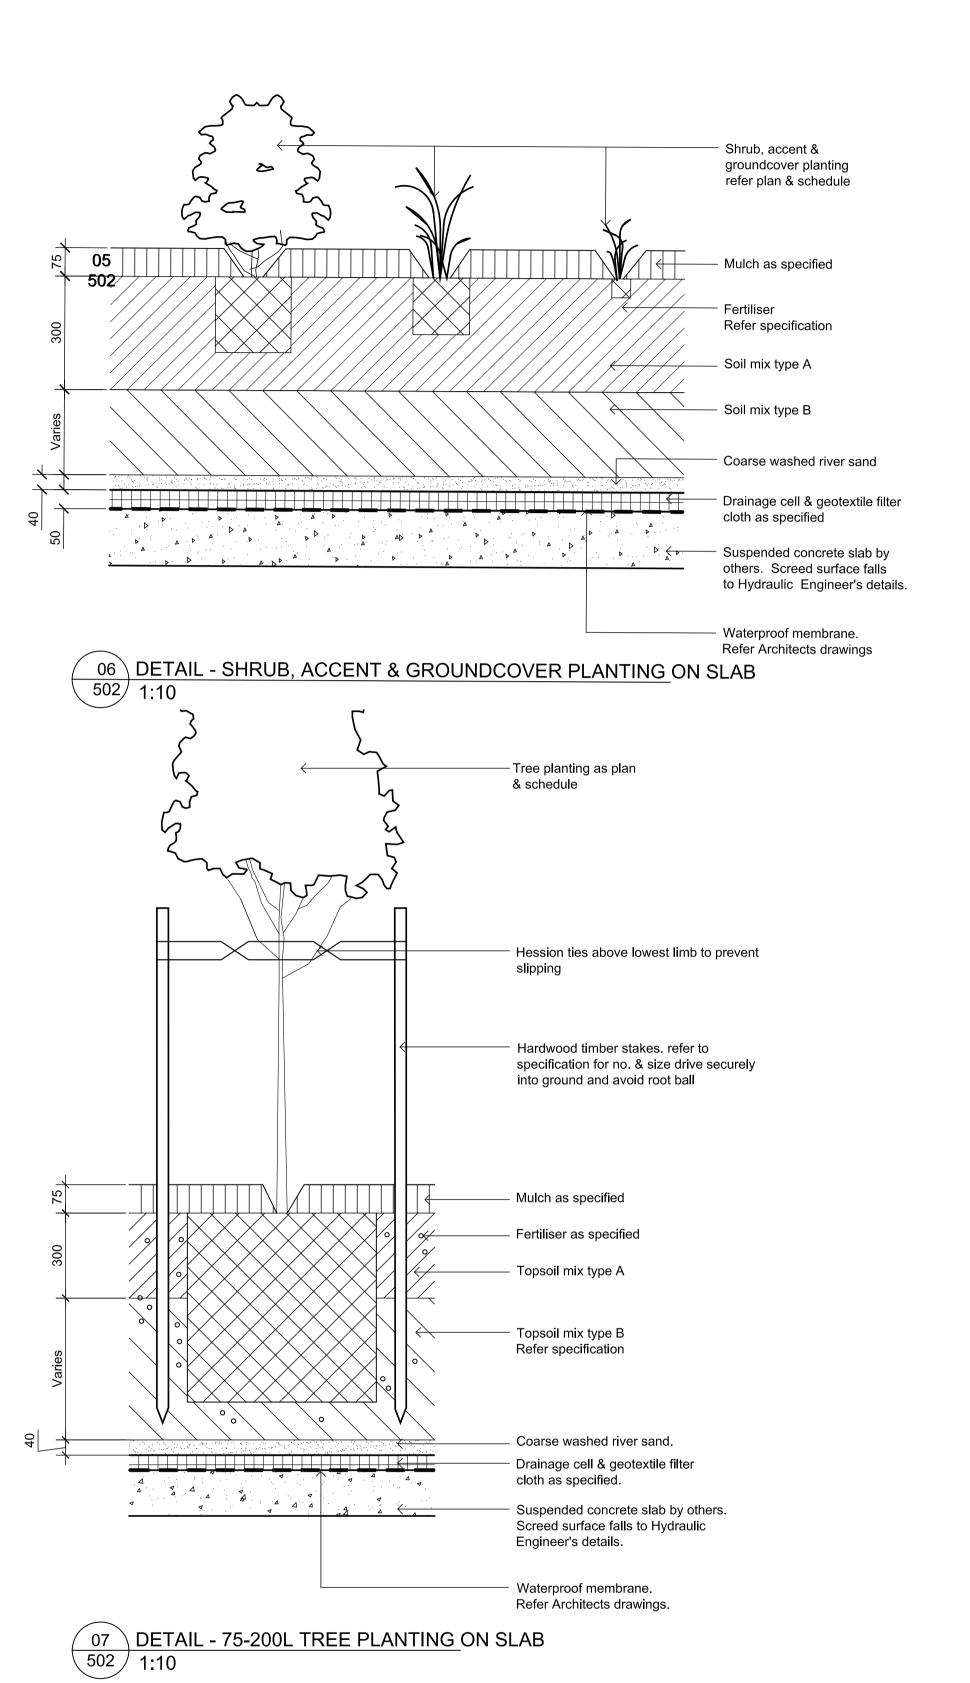

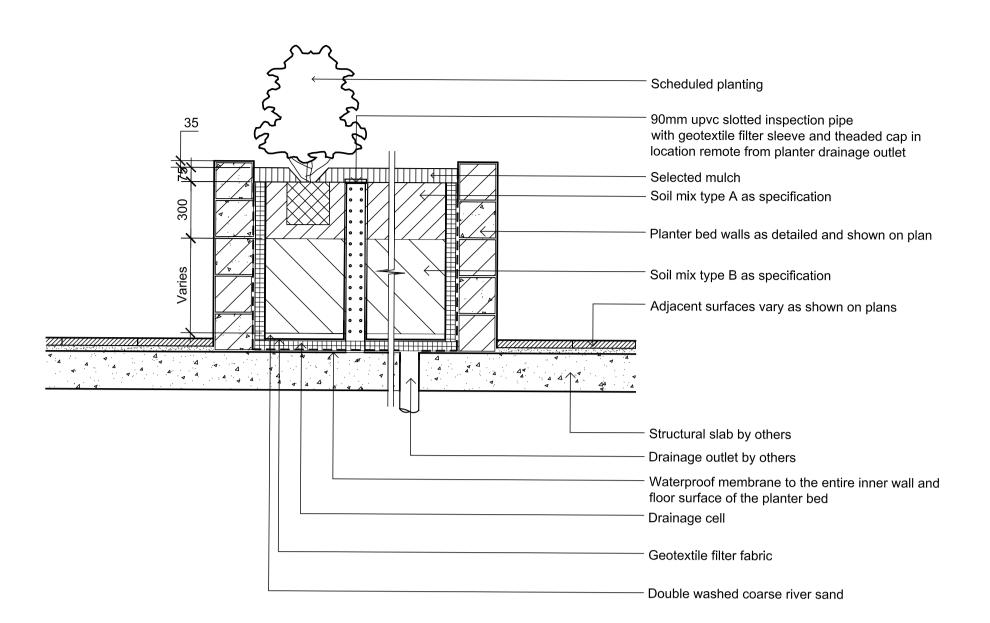

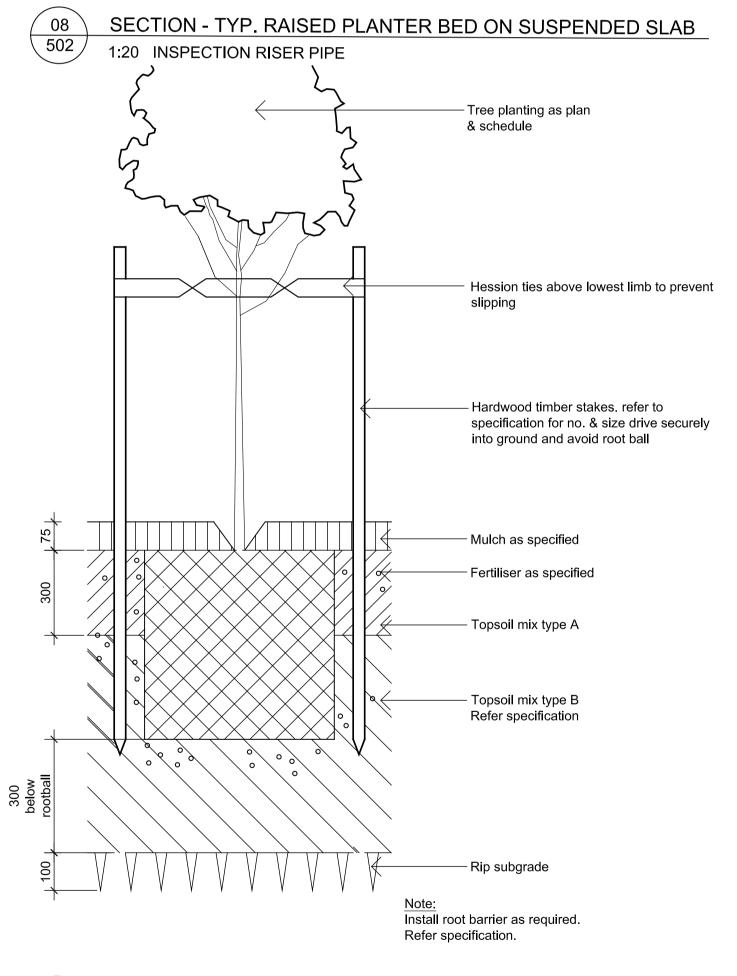

DETAIL - 75-200L TREE PLANTING ON GRADE 502

# NOT FOR CONSTRUCTION

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The contractor shall check and verify all work on site (including work by others) before commencing the landscape installation. Any discrepancies are to be reported to the Project Manager or Landscape Architect prior to commencing work. Do not scale this drawing. Any required dimensions not shown shall be referred to the Landscape Architect for confirmation.

NP RS 07.04.2017 NP RS 29.03.2017 Drawn Check Date

LEGEND





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Waldron Hill Projects Pty Ltd c/ 164 Parramatta Rd, Camperdown NSW 2050

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Drawing Name: Landscape Details

**DEVELOPMENT APPLICATION** 

Scale: As Shown Job Number:

Drawing Number SS17-3516 502 b

B Architectural Coordination A For DA Issue Revision Description